# REPUBLIC OF THE PHILIPPINES PHILIPPINE CARABAO CENTER DEPARTMENT OF AGRICULTURE

# Continuation of the Completion of the Construction of Institutional Herd Facilities at PCC CSU

Piat, Cagayan


- Communal Pens (House 4 & 5)
- Wastewater Treatment Facility




**VICINITY MAP** 



SITE DEVELOPMENT PLAN

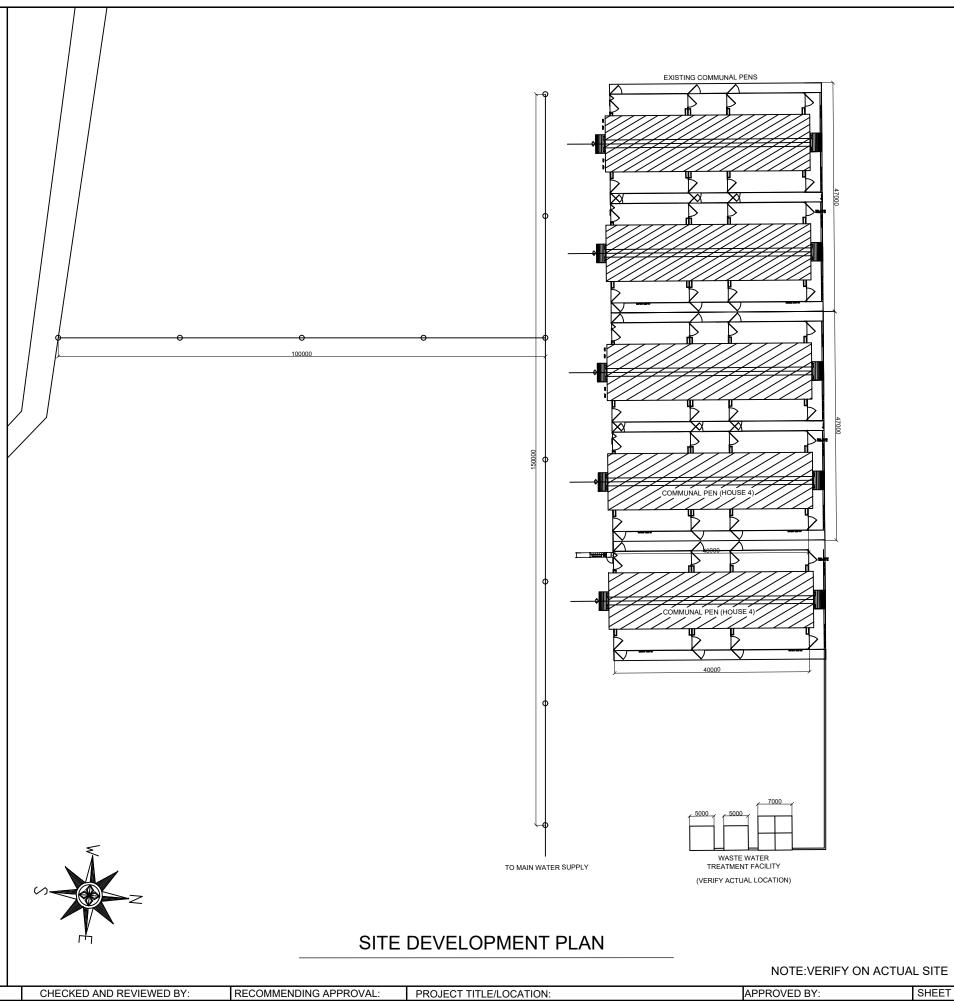



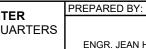

ENGR. JEAN HAROLD F. REAMICO ENGINEER I, LIVESTOCK ENGINEERING SECTION PHILIPPINE CARABAO CENTER

ENGR. CRIS Y. GUZON

HEAD, LIVESTOCK ENGINEERING SECTION PHILIPPINE CARABAO CENTER

DR. ROVINA R. PIÑERA CENTER DIRECTOR PHILIPPINE CARABAO CENTER - CSU **Continuation of the Completion of the Construction** of Institutional Herd Facilities at PCC-CSU Piat, Cagayan

SHEET No.

DR. LIZA G. BATTAD



# Remaining Works

## **Backfilling Works**


#### **Communal Pens:**

- Reinforced Concrete Works
  - Reinstallation of Anchor Bolt (J-type) at Concrete Column.
  - Fabrication of RSB for Column and FTB (Load/Unload Dock)
- Masonry Works
  - **Construction of Ramps**
- Construction of Loading/Unloading Dock (Located at Communal Pen House No. 5)
- Construction of Drinking Trough
- Construction of Drainage
- Metal Structure
- Installation of Column (Metal) and Beam
- Installation of Fence and Gates

- **Roofing Works**
- **Plumbing Works**
- **Electrical Works**


## **Wastewater Treatment Facility:**

- Reinforce Concrete Works
- Masonry and Plumbing Works

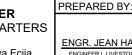




APPROVED BY:

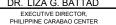




PERSPECTIVE

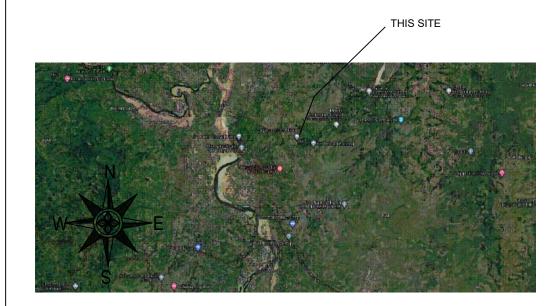

VICINITY MAP

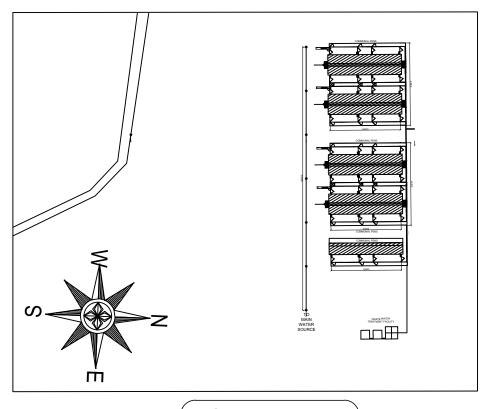

SITE DEV PLAN

CON	ITENTS	REPUBLIC OF THE PHILIPPINES
	CHITECTURAL PERSPECTIVE	
AUI	VICINITY MAP	
A02	FLOOR PLAN	OFFICE OF THE BUILDING OFFICIAL
A03	RIGHT SIDE ELEVATION LEFT SIDE ELEVATION	LINE & GRADE
A04	SECTION THRU "X-x" SECTION THRU "Y-y	
A05	FRONT ELEVATION REAR ELEVATION	
STR	UCTURAL	LAND USE & ZONING
S01	FOUNDATION PLAN	
S02	COLUMN FOOTING SCHEDULE CONNECTION DETAIL OF COLUMN W-F1 DETAIL COLUMN AND FOOTING DETAIL	
S03	RAILING DETAIL @ FEEDING THROUGH RAILING DETAIL DETAIL OF EMBEDDED STEEL RAILING	
S04	DETAIL OF GATE @ RUMP - UP DETAIL OF STEEL GATE DETAIL OF STEEL RAILING CONNECTION	ARCHITECTURAL
S05	DETAIL SECTION OF DRINKING TROUGH PLAN OF DRINKING TROUGH DETAIL OF CANAL DETAIL OF STEEL GATE LOCK DETAIL OF STEEL GATE	STRUCTURAL
	RAILING HINGED/CONNECTION DETAIL SECTION	STRUCTURAL
S06	ROOF FRAMING PLAN	
S07	DETAIL OF TRUSS-1 TRUSS SCHEDULE TYP. TRUSS ROOF BEAM CONNECTION DETAIL	
		SANITARY
PLU	MBING AND SANITARY	
P01	LEGEND SANITARY AND WATER SUPPLY LAY OUT	
P02	PLUMBING NOTES ISOMETRIC PLUMBING DIAGRAM	ELECTRICAL
ELE	CTRICAL	
E01	GENERAL ELECTRICAL NOTES ELECTRICAL LEGENDS	
E02	POWER LINE LAYOUT LIGHTING LAYOUT	
E03	RISER DIAGRAM SCHEDULE OF LOADS	MECHANICAL

PREPARED BY: PHILIPPINE CARABAO CENTER
NATIONAL GENE POOL & HEADQUARTERS

CLSU Cpd., Science City of Munoz, Nueva Ecija

AR. ANA FRANCESCA C. DUCUSIN ARCHITECT I, LIVESTOCK ENGINEERING SECTION, PHILIPPINE CARABAO CENTER

ENGR. CRIS Y. GUZON

HEAD, LIVESTOCK ENGINEERING SECTION, PHILIPPINE CARABAO CENTER

CHECKED AND REVIEWED BY:

RECOMMENDING APPROVAL: PROJECT TITLE/LOCATION:


CONTINUATION OF THE COMPLETION
OF THE CONSTRUCTION
OF INSTITUTIONAL HERD FACILITIES
AT PCC-CSU (COMMUNAL PEN 4 & 5)
PIAT, CAGAYAN


DRAFTED BY: SHEET CONTENTS: APPROVED BY: JHFR REVISION: AS SHOWN DR. LIZA G. BATTAD

EXECUTIVE DIRECTOR,
PHILIPPINE CARABAO CENTER


SHEET No.

A-01 01|17

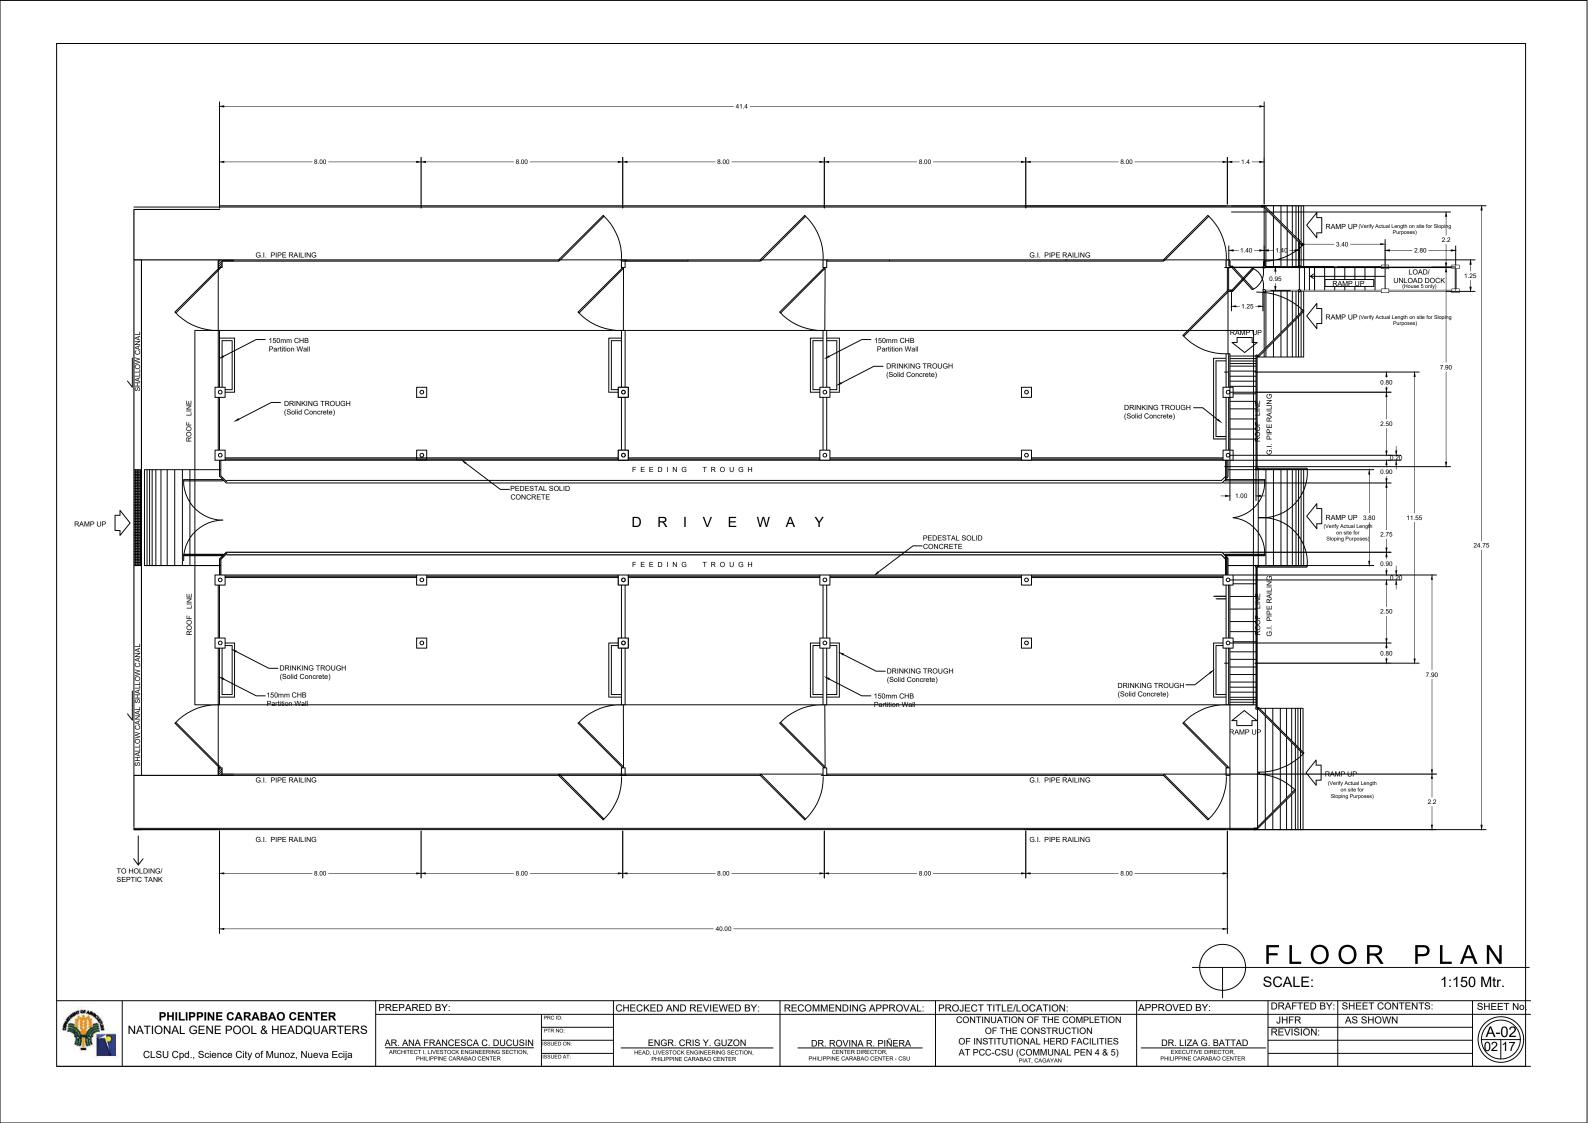

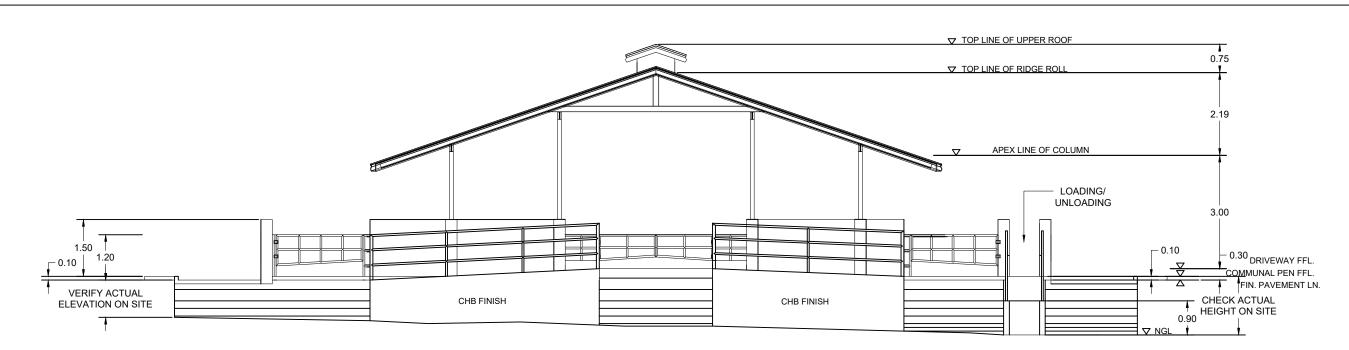




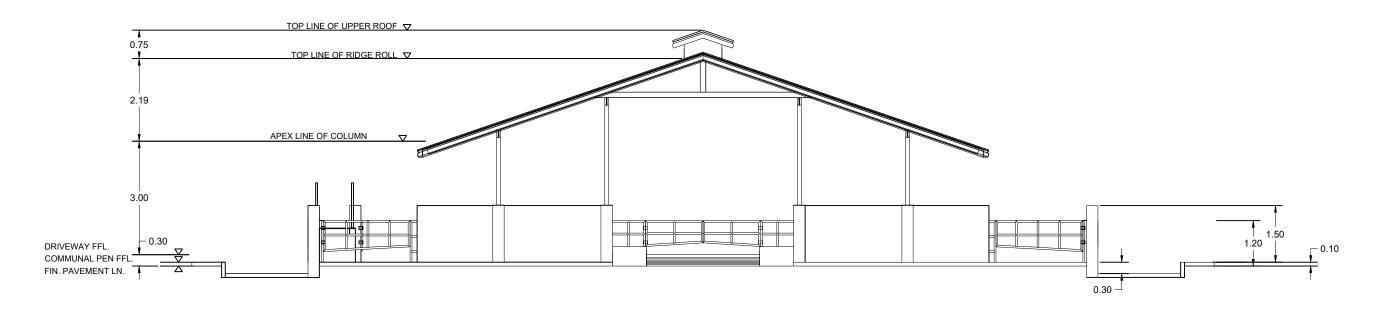




	DUIL IDDING OADADAO OFNITED	PREPARED BY:	CHECKED AND REVIEWED BY:	RECOMMENDING APPROVAL:	PROJECT TITLE/LOCATION:	APPROVED BY:	DRAFTED BY:	SHEET CONTENTS:	SHEET No.
Atto A	PHILIPPINE CARABAO CENTER	PRC ID:			CONTINUATION OF THE COMPLETION		JHFR	AS SHOWN	
8	NATIONAL GENE POOL & HEADQUARTERS	PTR NO:	1		OF THE CONSTRUCTION		REVISION:		1 //A-03\\
TO THE STATE OF		AR. ANA FRANCESCA C. DUCUSIN ISSUED ON:	ENGR. CRIS Y. GUZON	DR. ROVINA R. PIÑERA	OF INSTITUTIONAL HERD FACILITIES	DR. LIZA G. BATTAD			03 17
-	CLSU Cpd., Science City of Munoz, Nueva Ecija	ARCHITECT I, LIVESTOCK ENGINEERING SECTION, PHILIPPINE CARABAO CENTER  ISSUED AT:	HEAD, LIVESTOCK ENGINEERING SECTION, PHILIPPINE CARABAO CENTER	CENTER DIRECTOR, PHILIPPINE CARABAO CENTER - CSU	AT PCC-CSU (COMMUNAL PEN 4 & 5) PIAT, CAGAYAN	EXECUTIVE DIRECTOR, PHILIPPINE CARABAO CENTER			

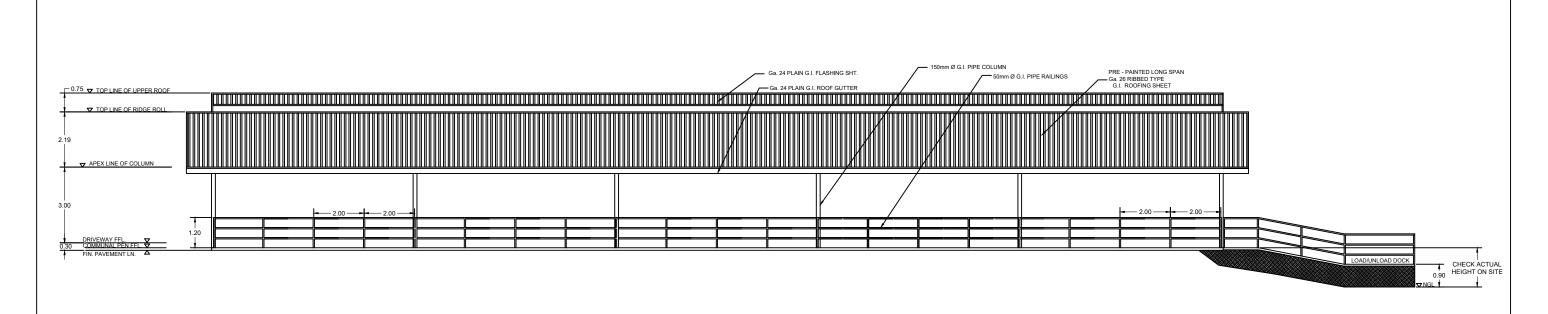




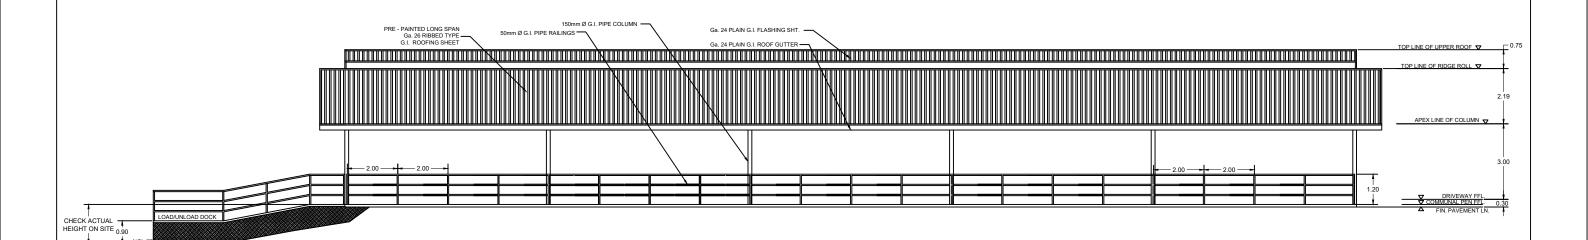




all 05 Ap.	DUM IDDING CADADAC CENTED	PREPARED BY:		CHECKED AND REVIEWED BY:	RECOMMENDING APPROVAL:	PROJECT TITLE/LOCATION:	APPROVED BY:	DRAFTED BY:	SHEET CONTENTS:	SHEET No.
Ann A	PHILIPPINE CARABAO CENTER		PRC ID:			CONTINUATION OF THE COMPLETION		JHFR	AS SHOWN	
8	NATIONAL GENE POOL & HEADQUARTERS		PTR NO:	7		OF THE CONSTRUCTION		REVISION:		□ //A-04\\
TO THE STATE OF TH		AR. ANA FRANCESCA C. DUCUSIN	SSUED ON:	ENGR. CRIS Y. GUZON	DR. ROVINA R. PIÑERA	OF INSTITUTIONAL HERD FACILITIES	DR. LIZA G. BATTAD			
- 1 -	CLSU Cpd., Science City of Munoz, Nueva Ecija	ARCHITECT I, LIVESTOCK ENGINEERING SECTION, PHILIPPINE CARABAO CENTER	SSUED AT:	HEAD, LIVESTOCK ENGINEERING SECTION, PHILIPPINE CARABAO CENTER	CENTER DIRECTOR, PHILIPPINE CARABAO CENTER - CSU	AT PCC-CSU (COMMUNAL PEN 4 & 5) PIAT, CAGAYAN	EXECUTIVE DIRECTOR, PHILIPPINE CARABAO CENTER			04 17

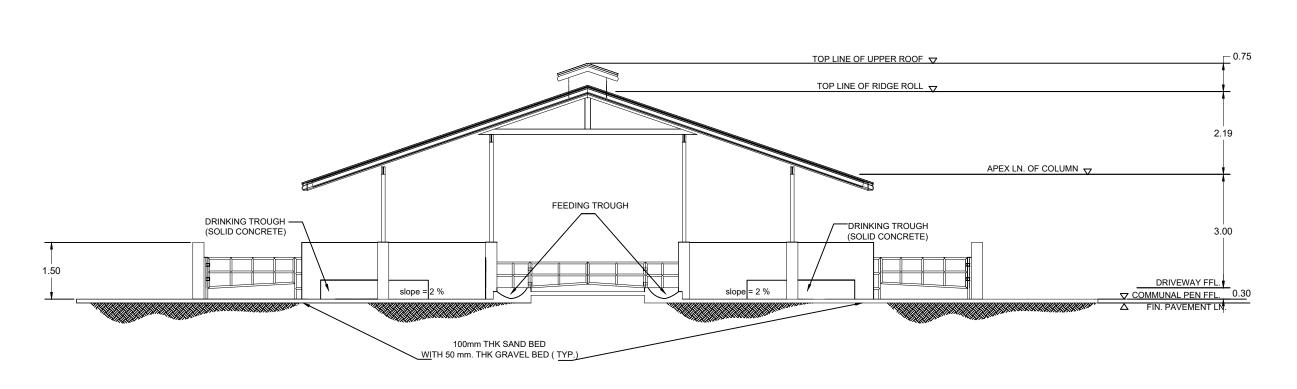




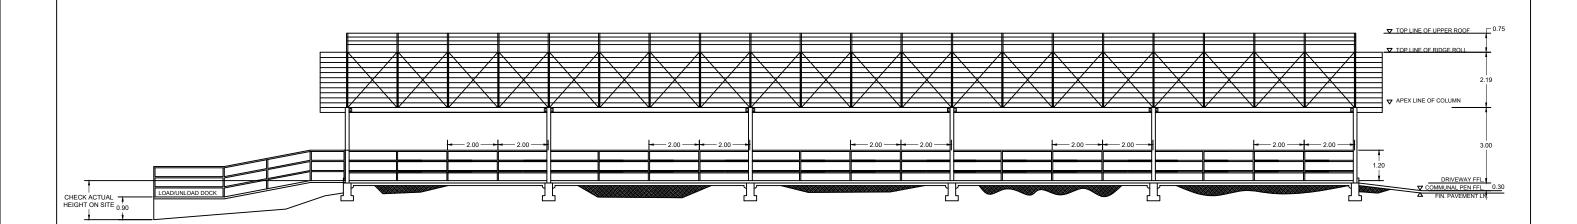





of Of An	DUIL IDDING CADADAC CENTED	PREPARED BY:		CHECKED AND REVIEWED BY:	RECOMMENDING APPROVAL:	PROJECT TITLE/LOCATION:	APPROVED BY:	DRAFTED BY:	SHEET CONTENTS:	SHEET No.
Contract of	PHILIPPINE CARABAO CENTER	PRC ID:				CONTINUATION OF THE COMPLETION		JHFR	AS SHOWN	
8	NATIONAL GENE POOL & HEADQUARTERS	PTR NO:	):	1		OF THE CONSTRUCTION		REVISION:		□//A-05\\
and T		AR. ANA FRANCESCA C. DUCUSIN ISSUED O	ON:	ENGR. CRIS Y. GUZON	DR. ROVINA R. PIÑERA	OF INSTITUTIONAL HERD FACILITIES	DR. LIZA G. BATTAD			1(05117))
- 1	CLSU Cpd., Science City of Munoz, Nueva Ecija	ARCHITECT I, LIVESTOCK ENGINEERING SECTION, PHILIPPINE CARABAO CENTER ISSUED A	AT:	HEAD, LIVESTOCK ENGINEERING SECTION, PHILIPPINE CARABAO CENTER	CENTER DIRECTOR, PHILIPPINE CARABAO CENTER - CSU	AT PCC-CSU (COMMUNAL PEN 4 & 5)	EXECUTIVE DIRECTOR, PHILIPPINE CARABAO CENTER			05 17
				THEIR HILL OF WILL OF OUT THE		PIAT, CAGATAN				

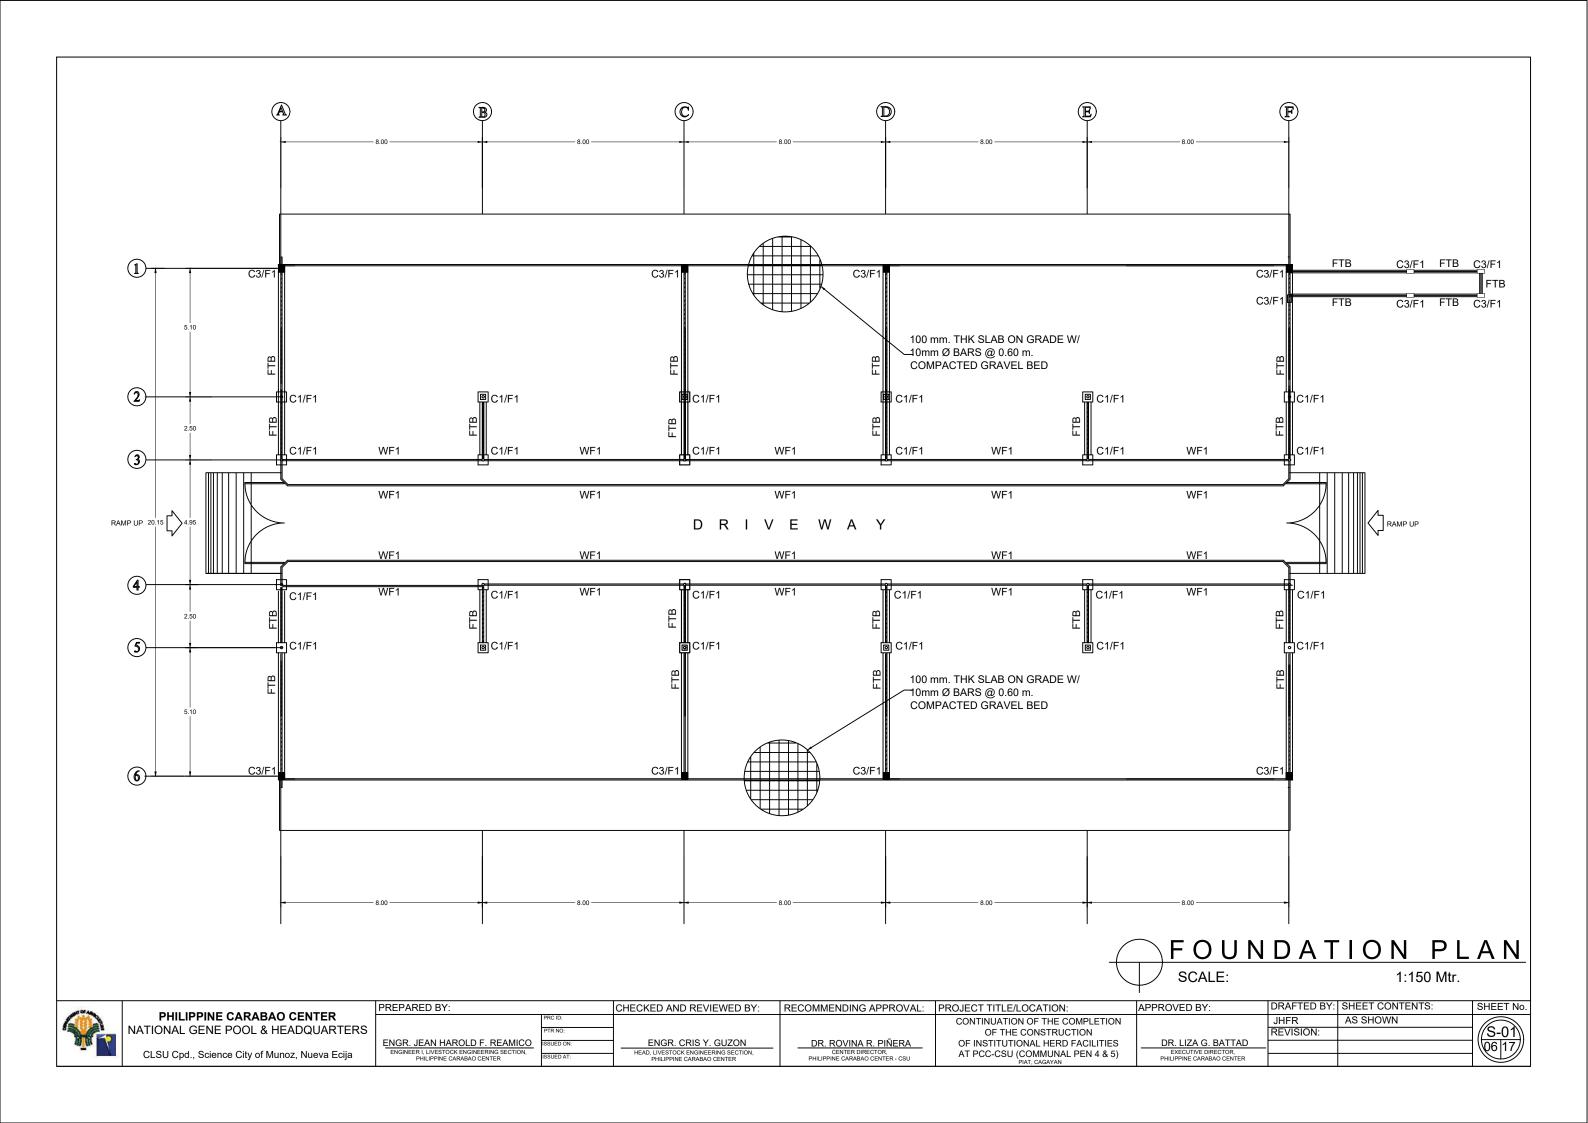

#### COLUMN FOOTING SCHEDULE

NAA DIG	T)/DE	PRC	PERTIES , r	nm	05051011
MARK	TYPE	T W L		SECTION	
F1	CONC.	25	900	900	
C1	CONC.	300	300	SEE PLAN DETAIL	
C-1	C-1 G.I.		150 Ø	SEE PLAN DETAIL	
С3	CONC.	150	300	1500	

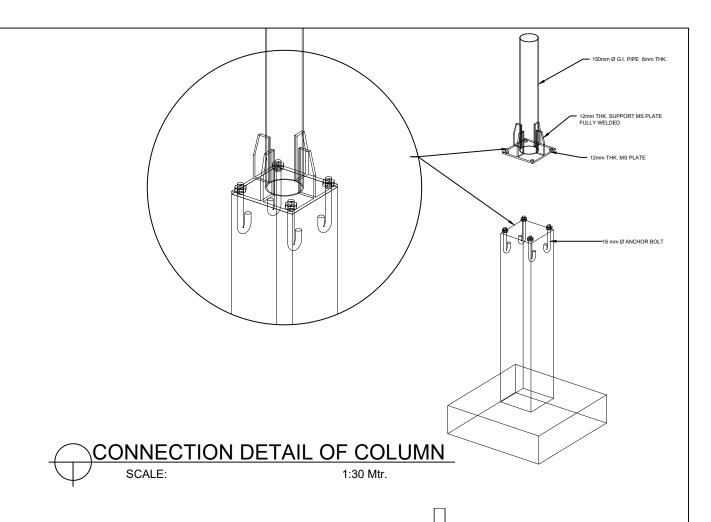

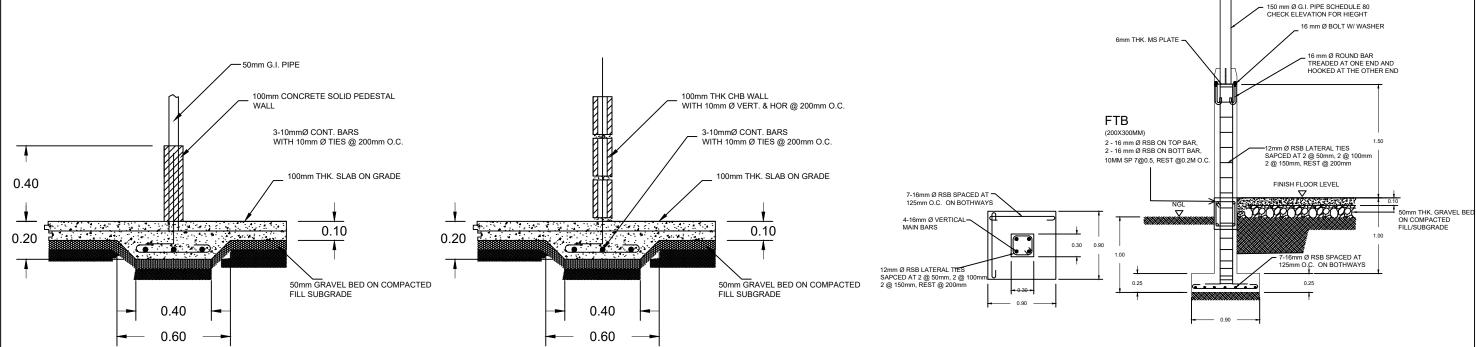





PHILIPPINE CARABAO CENTER NATIONAL GENE POOL & HEADQUAR
 CLSU Cpd., Science City of Munoz, Nueva


NTED	PR
NTER QUARTERS	EI
lueva Ecija	딕


PREPARED BY:	CHECKED AND REVIEWED BY:	
ENGR. JEAN HAROLD F. REAMICO	PRC ID:  PTR NO:  ISSUED ON:	ENGR. CRIS Y. GUZON
ENGINEER I, LIVESTOCK ENGINEERING SECTION, PHILIPPINE CARABAO CENTER	ISSUED AT:	HEAD, LIVESTOCK ENGINEERING SECTION, PHILIPPINE CARABAO CENTER

ENGR. CRIS Y. GUZON	DR. ROVINA R. PIÑERA
EAD, LIVESTOCK ENGINEERING SECTION, PHILIPPINE CARABAO CENTER	CENTER DIRECTOR, PHILIPPINE CARABAO CENTER - CSU
THEIT INC GATGERO GENTER	THEN THE ONE DAY OF THE CONTROL OF

	RECOMMENDING APPROVAL:	PROJECT TITLE/LOCATION:
	DR. ROVINA R. PIÑERA  CENTER DIRECTOR. PHILIPPINE CARABBAO CENTER - CSU	CONTINUATION OF THE COMPLETION OF THE CONSTRUCTION OF INSTITUTIONAL HERD FACILITIES AT PCC-CSU (COMMUNAL PEN 4 & 5)
_		PIAT, CAGAYAN

APPROVED BY:	DRAFTED BY:	SHEET CONTENTS:
	JHFR	AS SHOWN
	REVISION:	
DR. LIZA G. BATTAD		
EXECUTIVE DIRECTOR,		
PHILIPPINE CARABAO CENTER		

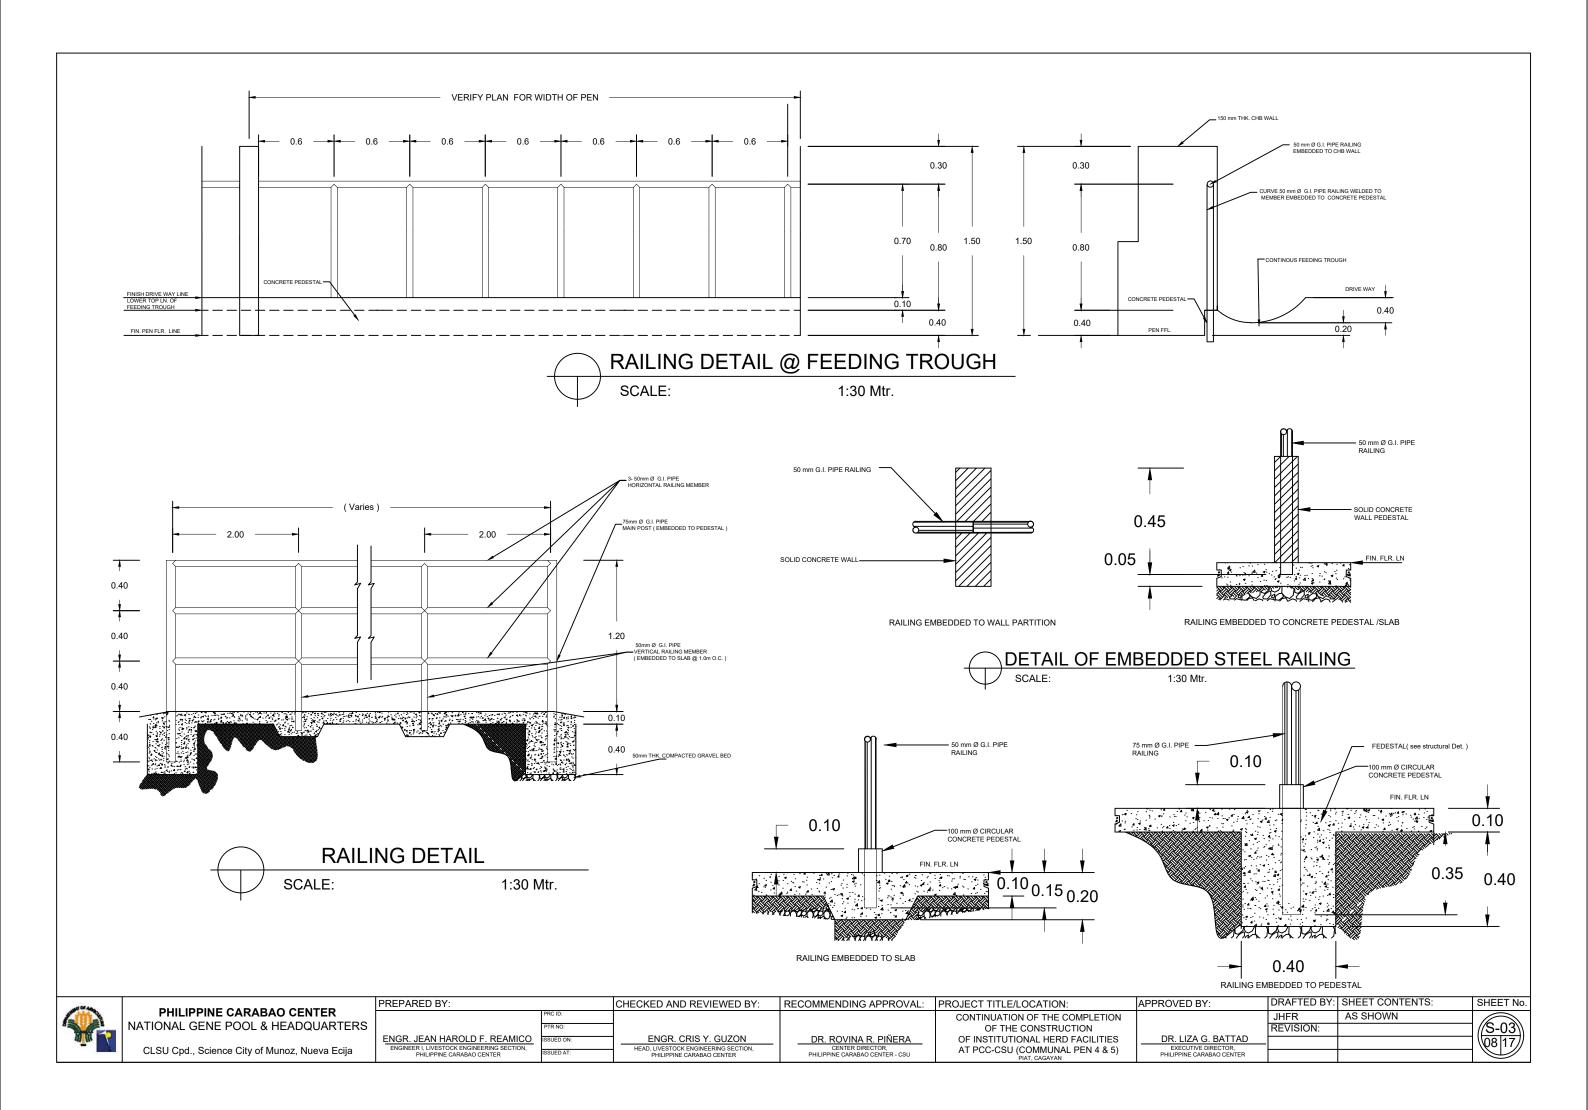

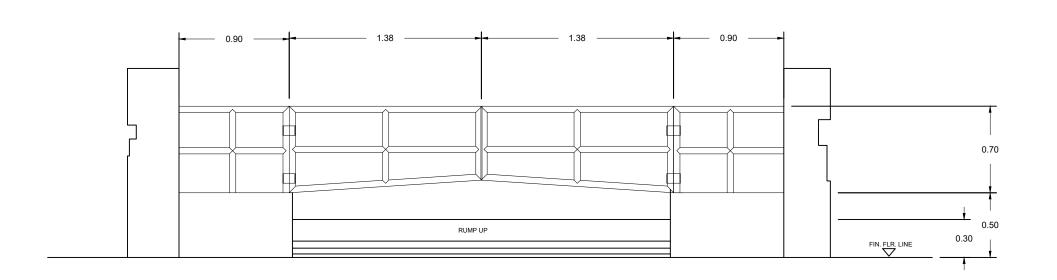

DETAIL OF GATE @ RUMP - UP


1:30 Mtr.

DETAIL OF STEEL RAILING CONNECTION
SCALE: 1:30 Mtr.


SCALE:


DETAIL OF STEEL GATE

SCALE:

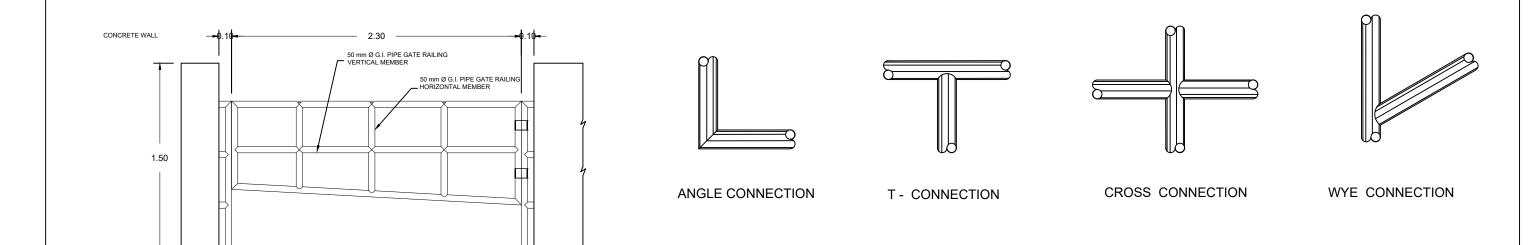


of Of Age	DUIL IDDING CADADAO OFNITED	PREPARED BY:		CHECKED AND REVIEWED BY:	RECOMMENDING APPROVAL:	PROJECT TITLE/LOCATION:	APPROVED BY:	DRAFTED BY:	SHEET CONTENTS:	SHEET No.
	PHILIPPINE CARABAO CENTER  NATIONAL GENE POOL & HEADQUARTERS	Pi	RC ID:			CONTINUATION OF THE COMPLETION OF THE CONSTRUCTION		JHFR REVISION:	AS SHOWN	(S-04)
Min 3		l	SUED ON:	ENGR. CRIS Y. GUZON	DR. ROVINA R. PIÑERA  CENTER DIRECTOR.	OF INSTITUTIONAL HERD FACILITIES	DR. LIZA G. BATTAD  EXECUTIVE DIRECTOR.	- INEVISION.		(09 17)
	CLSU Cpd., Science City of Munoz, Nueva Ecija		SUED AT:	HEAD, LIVESTOCK ENGINEERING SECTION, PHILIPPINE CARABAO CENTER	PHILIPPINE CARABAO CENTER - CSU	AT PCC-CSU (COMMUNAL PEN 4 & 5) PIAT, CAGAYAN	PHILIPPINE CARABAO CENTER			

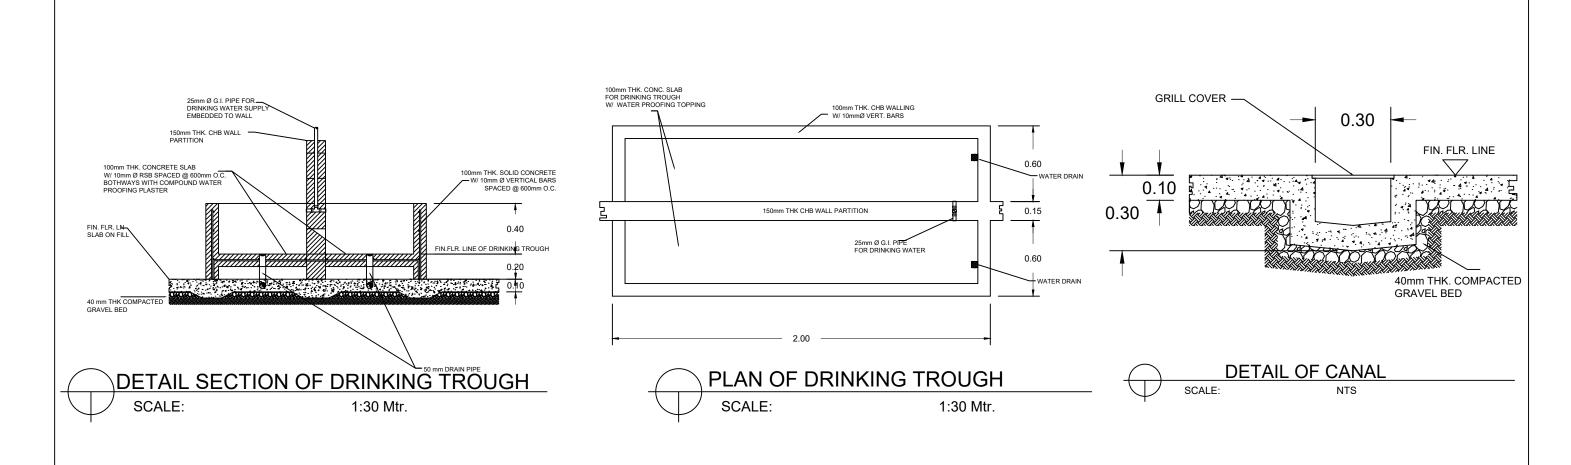

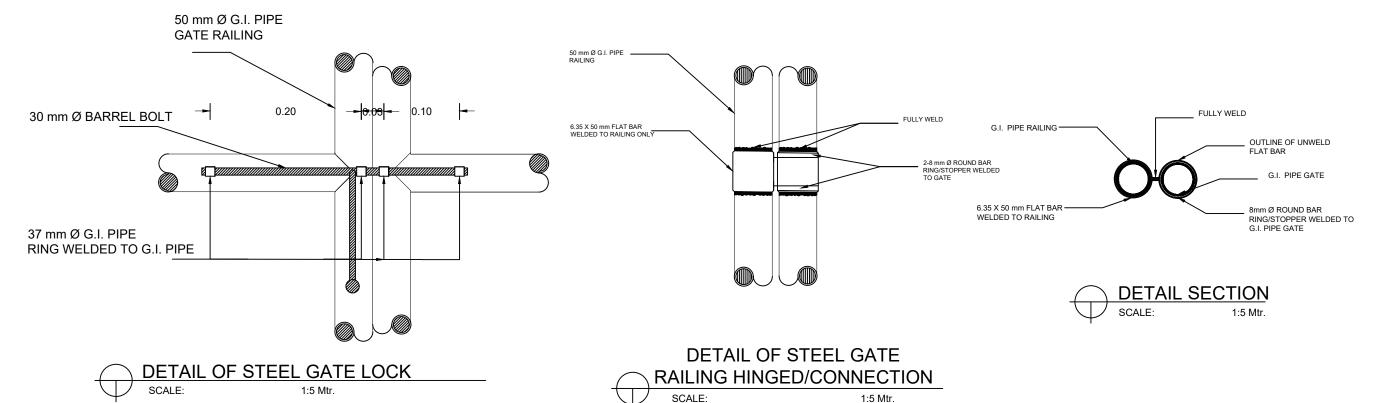


ad Of An	DUIL IDDING CADADAG CENTED	PREPARED BY:	CHECKED AND REVIEWED BY:	RECOMMENDING APPROVAL:	PROJECT TITLE/LOCATION:	APPROVED BY:	DRAFTED BY:	SHEET CONTENTS:	SHEET No.
Contract of the second	PHILIPPINE CARABAO CENTER	PRC ID:			CONTINUATION OF THE COMPLETION		JHFR	AS SHOWN	
	NATIONAL GENE POOL & HEADQUARTERS				OF THE CONSTRUCTION		REVISION:		ˈˈ//S-0 <i>5</i> \\
an In		ENGR. JEAN HAROLD F. REAMICO ISSUED ON:	ENGR. CRIS Y. GUZON	DR. ROVINA R. PIÑERA	OF INSTITUTIONAL HERD FACILITIES	DR. LIZA G. BATTAD			1017
	CLSU Cpd., Science City of Munoz, Nueva Ecija	ENGINEER I, LIVESTOCK ENGINEERING SECTION, PHILIPPINE CARABAO CENTER ISSUED AT:	HEAD, LIVESTOCK ENGINEERING SECTION, PHILIPPINE CARABAO CENTER	CENTER DIRECTOR, PHILIPPINE CARABAO CENTER - CSU	AT PCC-CSU (COMMUNAL PEN 4 & 5) PIAT, CAGAYAN	EXECUTIVE DIRECTOR, PHILIPPINE CARABAO CENTER			

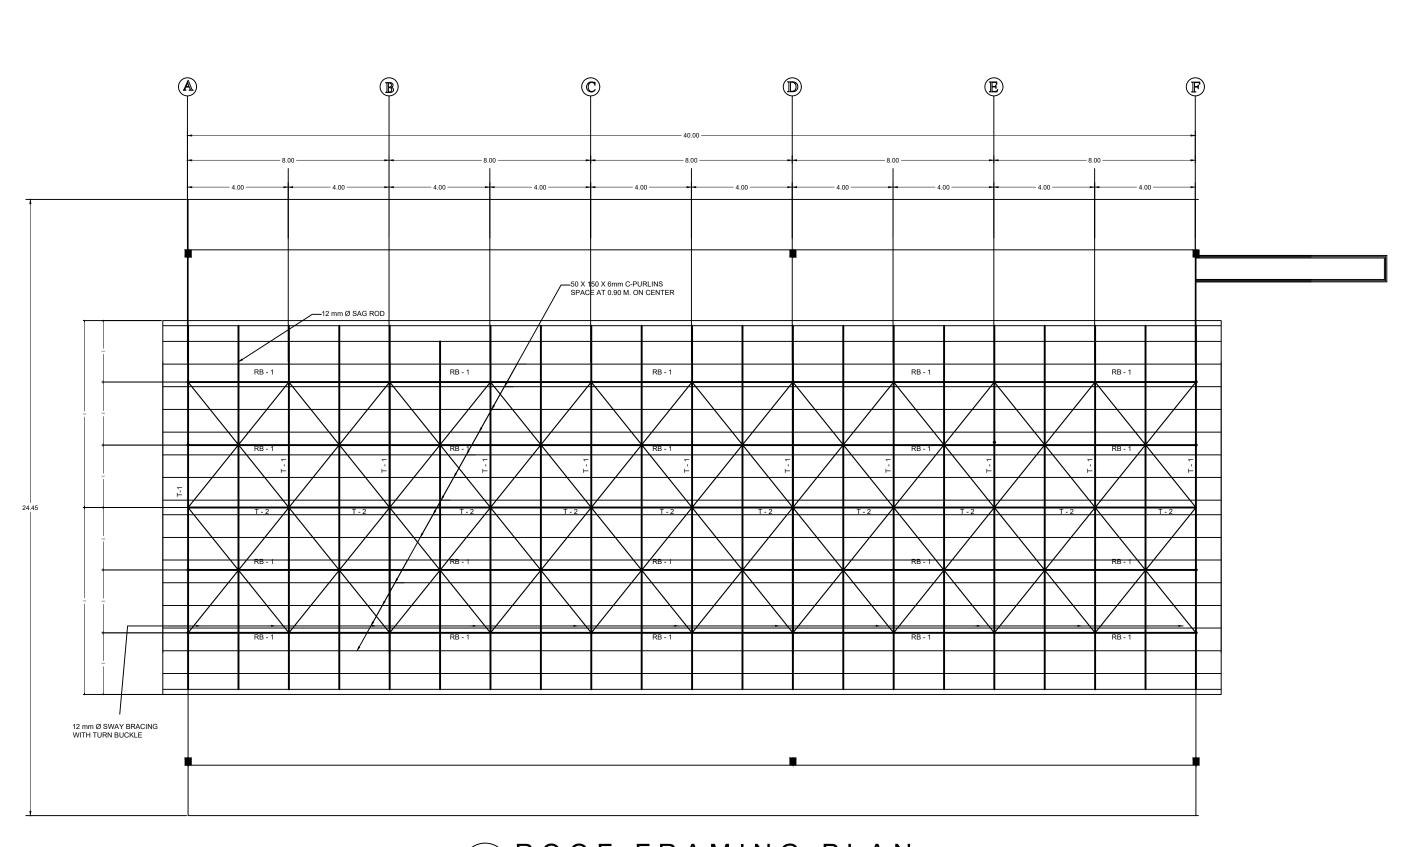




of de	DUIL IDDING CADADAC CENTED	PREPARED BY:	CHECKED AND REVIEWED BY:	RECOMMENDING APPROVAL:	PROJECT TITLE/LOCATION:	APPROVED BY:	DRAFTED BY:	SHEET CONTENTS:	SHEET No.
	PHILIPPINE CARABAO CENTER	PRC ID:			CONTINUATION OF THE COMPLETION		JHFR	AS SHOWN	
	NATIONAL GENE POOL & HEADQUARTERS				OF THE CONSTRUCTION		REVISION:		7 /∕S-06\\
an In		ENGR. JEAN HAROLD F. REAMICO ISSUED ON:	ENGR. CRIS Y. GUZON	DR. ROVINA R. PIÑERA	OF INSTITUTIONAL HERD FACILITIES	DR. LIZA G. BATTAD	-		7 ( <u>1117</u> 7)
	CLSU Cpd., Science City of Munoz, Nueva Ecija	ENGINEER I, LIVESTOCK ENGINEERING SECTION, PHILIPPINE CARABAO CENTER ISSUED AT:	HEAD, LIVESTOCK ENGINEERING SECTION, PHILIPPINE CARABAO CENTER	CENTER DIRECTOR, PHILIPPINE CARABAO CENTER - CSU	AT PCC-CSU (COMMUNAL PEN 4 & 5) PIAT, CAGAYAN	EXECUTIVE DIRECTOR, PHILIPPINE CARABAO CENTER			

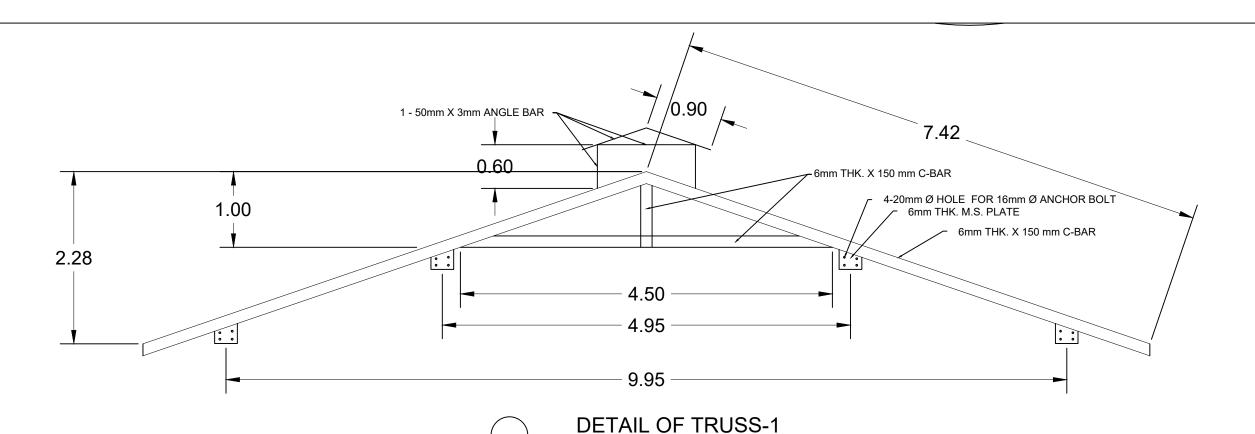

#### TRUSS SCHEDULE

NAA DIC	T) (DE	TRUS	OFOTION				
MARK	TYPE	Т	W L		SECTION		
T-2	C-BAR	6	50	150			
RB-1	C-BAR (DOUBLE)	6	50	200			
T-1		SE	SEE T-1 DETAILS				

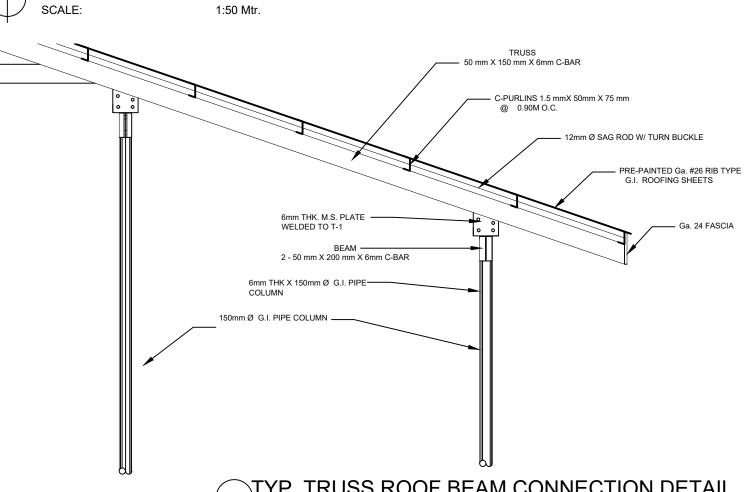

TYP. TRUSS ROOF BEAM CONNECTION DETAIL SCALE: 1:30 Mtr.



PHILIPPINE CARABAO CENTER NATIONAL GENE POOL & HEADQUARTERS CLSU Cpd., Science City of Munoz, Nueva Ecija

PREPARED BY:

ENGR. JEAN HAROLD F. REAMICO
ENGINEER I, LIVESTOCK ENGINEERING SECTION,
PHILIPPINE CARABAO CENTER

CHECKED AND REVIEWED BY: ENGR. CRIS Y. GUZON

DR. ROVINA R. PIÑERA

CENTER DIRECTOR,
PHILIPPINE CARABAO CENTER - CSU


RECOMMENDING APPROVAL: PROJECT TITLE/LOCATION: CONTINUATION OF THE COMPLETION OF THE CONSTRUCTION
OF THE CONSTRUCTION
OF INSTITUTIONAL HERD FACILITIES
AT PCC-CSU (COMMUNAL PEN 4 & 5)
PIAT, CAGAYAN


DRAFTED BY: SHEET CONTENTS: APPROVED BY: AS SHOWN JHFR REVISION: DR. LIZA G. BATTAD

EXECUTIVE DIRECTOR,
PHILIPPINE CARABAO CENTER

SHEET No.

S-07 12 17

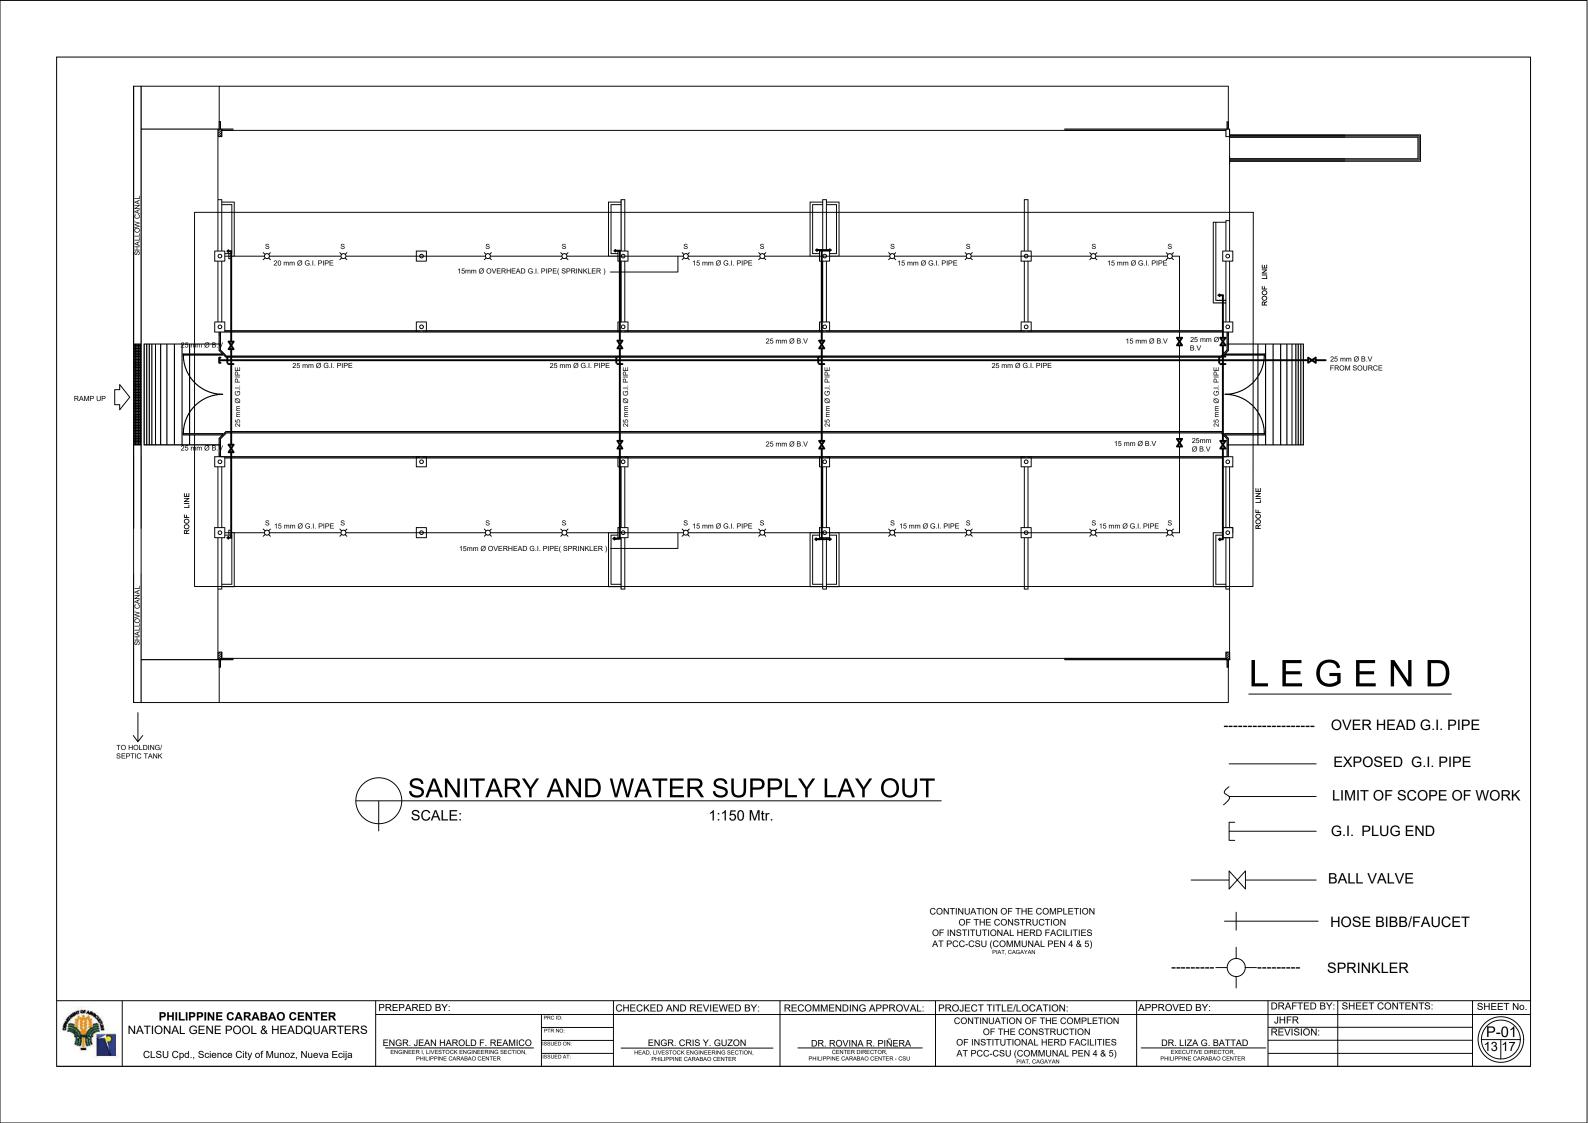

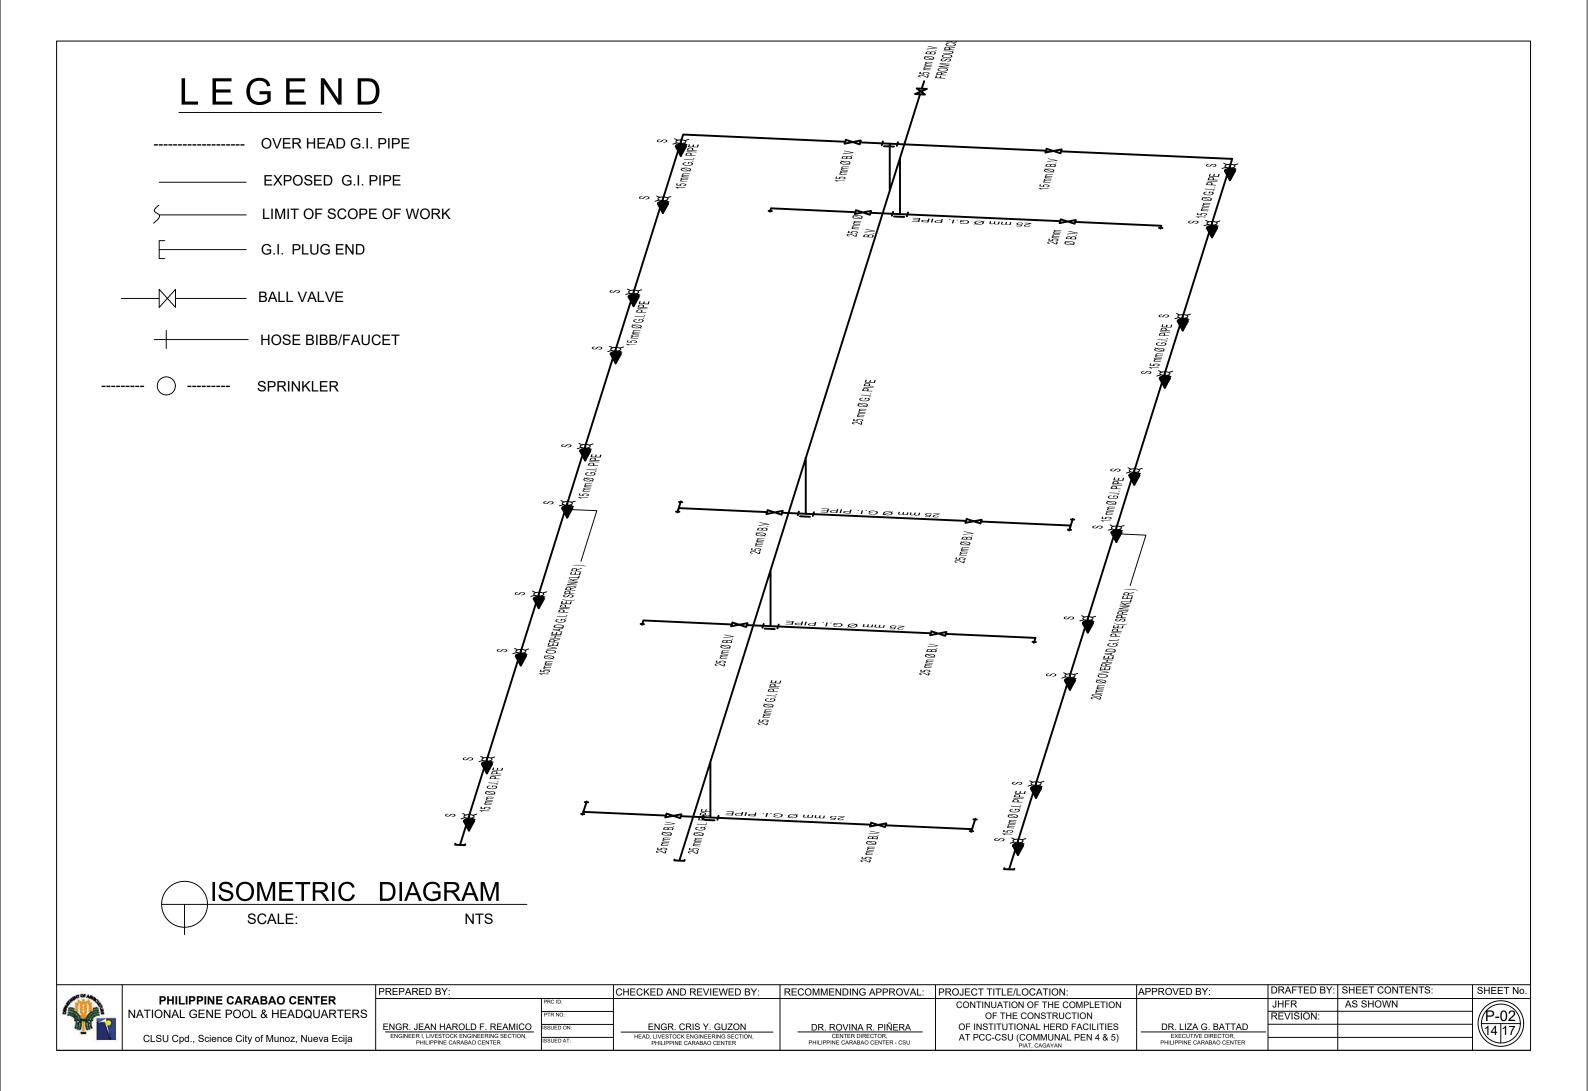

#### GENERAL NOTES AND SPECIFICATIONS

- 1. ALL ELECTRICAL WORKS SHALL COMPLY WITH THE PROVISION OF THE LATEST EDI-TION OF THE NATIONAL ELECTRICAL CODE WITH THE RULES & REGULATION OF THE NATIONAL AND LOCAL AUTHORITIES CONCERN IN THE ENFORCEMENT OF THE ELECTRICAL LAWS AND REGULATIONS OF THE UTILITY COMPANIES CONCERN.
- 2. SERVICE ENTRANCE VOLTAGE TO THE BUILDING SHALL 115 / 220 VOLTS, 60 HERTZ, SINGLE PHASE.
- 3. THE CONTRUCTOR SHALL VERIFY AND ORIENT THE ACTUAL LOCATION OF CONCRETE TERMI-NAL POLE FOR CONNECTION TO THE POWER SUPPLY AND TELEPHONE.
- 4. ALL INSTALLATION CONCEALED FROM VIEW WIRING SHALL BE IN CASE OF POLYVINIL CHLORIDE PVC SCHEDULE 40 EXCEPT POWER & TELEPHONE SERVICE W/C SHALL BE RIGID STEEL CONDUIT (RSC) OR OTHER **WISE NOTED.**

- 5. PULL BOXES OF APPROPRIATE SIZE SHALL BE PROVIDED, EVEN IF NOT INDICATED IN DRAWING TO ACCOMODATE THE NUMBER OF SPICES OF WIRE.
- 6. ALL MATERIALS TO BE USED SHALL BE BRAND OUTLET NEW AND APPROVED TYPE APPROPRIATE FOR DROP TYPE OIUTLET **BOTH LOCATION AND INTENDED USE.**
- 7. ELECTRICAL INSTALLATIONS SHALL BE THE DIRECT SUPERVISION OF A DULY LICENSED **ELECTRICAL ENGINEER OR A REGISTERED** MASTER ELECTRICIAN.
- 8. NO REVISION IN THE DESIGN SHALL BE DONE W/O THE PRIOR KNOWLEDGE& APPROVAL OF THE DESIGNER & THE OWNER, ANY SUCH **REVISIONS DONE W/O APPROVAL SHALL BE** CAUSE RESPONSIBILITY OF THE DESIGNER TO CEASE AS A WHOLE.

#### **ELECTRICAL SYMBOLS**

PANEL BOARD (THE NUMBERS INDICATES LIGHTING **PANEL NUMBER)** 



WEATHERPROOF CONVINIENCE





**WATER PUMP OUTLET** 



**GROUND** 



SINGLE POLE SWITCH

**SERVICE ENTRANCE** 



DUPLEX SWITCH, 2 SINGLE POLE SWITCHES  $\mathbf{S}_{ab}$ ON ONE GANG SWITCH PLATE



(INDICATE THE NUMBER OF CONDUCTOR **SIZE, TYPE AND VOLTAGE)** 



**COMPACT FLOURESCENT LAMP** 



SERVICE KILOWATT-HOUR METER



CIRCUIT BREAKER (INDICATE TYPE AND Kv SETTING)



SHEET No.

E-01

15 17




AO OFNITED	Γ
AO CENTER HEADQUARTERS	
Junoz, Nueva Ecija	

TED	PRE
TER JARTERS	
eva Ecija	

EPARED BY:		CHECKED AND REVIEWED BY:
	PRC ID:	
	PTR NO:	
	ISSUED ON:	ENGR. CRIS Y. GUZON
	ISSUED AT:	HEAD, LIVESTOCK ENGINEERING SECTION,

RECOMMENDING APPROVAL:

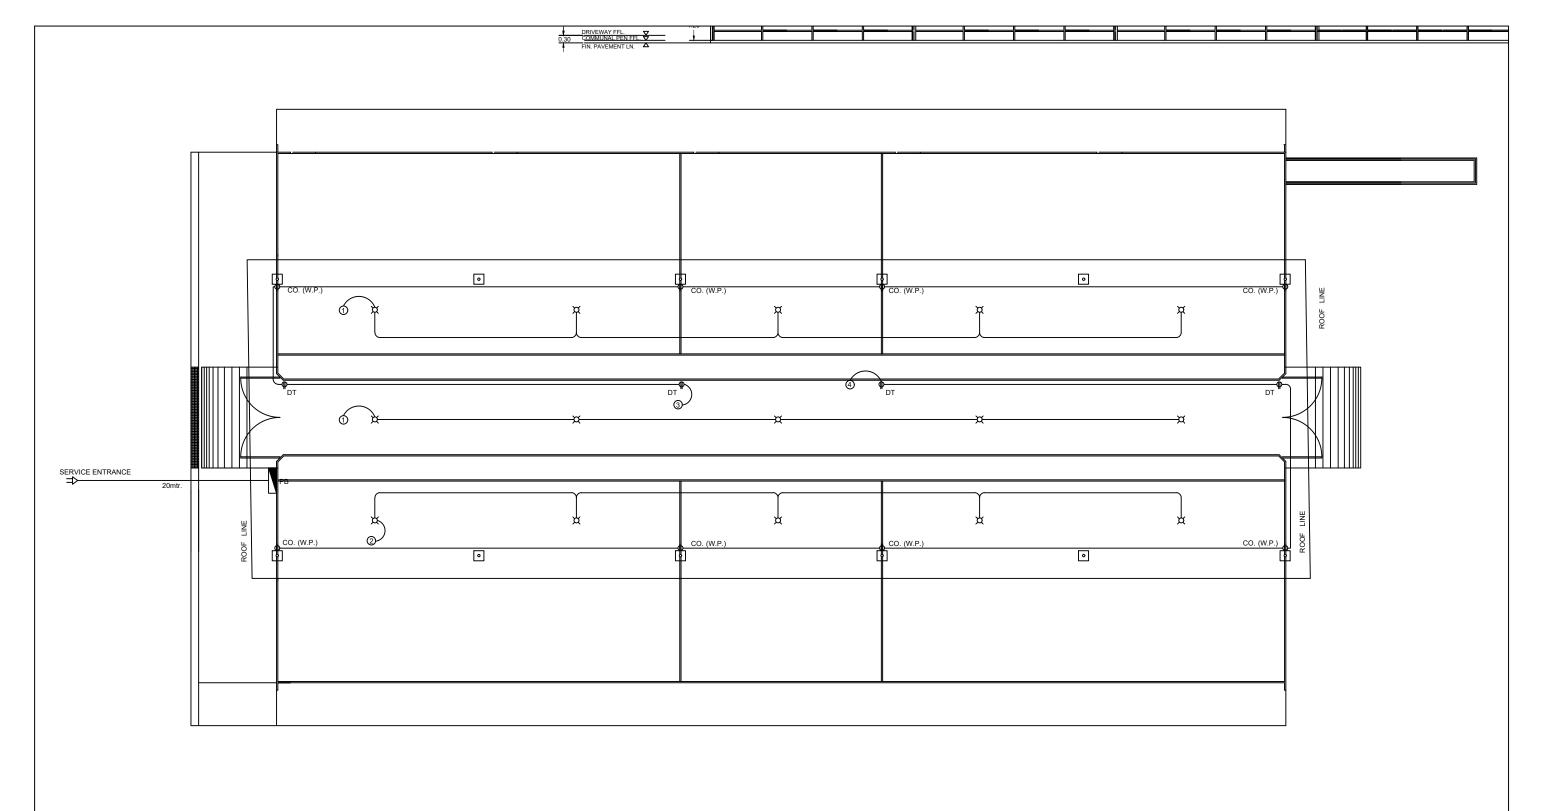



of Of Age	DULL IDDING CADADAC CENTED	PREPARED BY:	CHECKED AND REVIEWED BY:	RECOMMENDING APPROVAL:	PROJECT TITLE/LOCATION:	APPROVED BY:	DRAFTED BY:	SHEET CONTENTS:	SHEET No.
<b>Ama</b>	PHILIPPINE CARABAO CENTER	PRC ID:			CONTINUATION OF THE COMPLETION		JHFR	AS SHOWN	
8	NATIONAL GENE POOL & HEADQUARTERS	PTR NO:			OF THE CONSTRUCTION		REVISION:		□ //E-02\\
THE DIE		ISSUED ON:	ENGR. CRIS Y. GUZON	DR. ROVINA R. PIÑERA	OF INSTITUTIONAL HERD FACILITIES	DR. LIZA G. BATTAD	_		16 17
	CLSU Cpd., Science City of Munoz, Nueva Ecija	ISSUED AT:	HEAD, LIVESTOCK ENGINEERING SECTION, PHILIPPINE CARABAO CENTER	CENTER DIRECTOR, PHILIPPINE CARABAO CENTER - CSU	AT PCC-CSU (COMMUNAL PEN 4 & 5) PIAT, CAGAYAN	EXECUTIVE DIRECTOR, PHILIPPINE CARABAO CENTER			

#### SCHEDULE OF LOADS

PANEL BOARD: LP ( NEMA )

RATING: I OOAF


CIRCUIT NO.	DESCRIPTION	NO. OF OUTLET	WATTS	VOLTS	AMPS	CIRCUIT BREAKER	POLES	CONDUCTOR THHNMM <sup>2</sup>	CONDUIT RSCMM²
1	LIGHTING OUTLET	5	500	220	2.27	15	2	22.0 I2.0	115
2	LIGHTING OUTLET	5	500	220	2.27	15	2	22.0 I2.0	115
3	LIGHTING OUTLET	5	500	220	2.27	15	2	23.5 I2.0	115
4	SMALL APPLIANCES LOAD	6	1200	220	5.45	20	2	23.5 I2.0	115
5	SMALL APPLIANCES LOAD	6	1200	220	5.45	20	2	23.5 I2.0	115
6	SUBMERSIBLE PUMP MOTOR 1.5 H.P.	1	1760	220	10	30	2	23.5  2.0	115
7	SPARE			220		30			
8	SPARE			220		30			
		SUBTOTAL	5660		27.71				

 $I = 27.71 \times 220/1000 = 6.09 \text{kva}$ 

USE =50 ampere trip MAIN CIRCUIT BREAKER

USE 2- 8.0 mm<sup>2</sup> THHN FEEDER LINE 1- 3.5 mm<sup>2</sup> THHN GRND.WIRE

IN 20mm Ø RSC PIPE

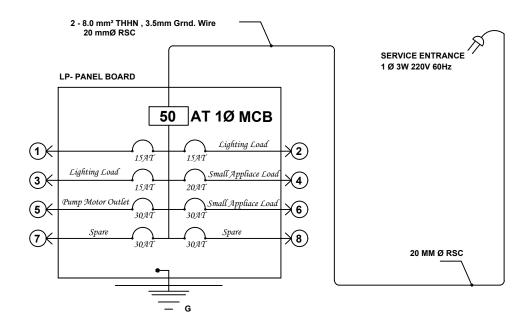

#### **RISER DIAGRAM**

	DUU IDDING CADADAC CENTED	PREPARED BY:	CHECKED AND REVIEWED BY:	RECOMMENDING APPROVAL:	PROJECT TITLE/LOCATION:	APPROVED BY:	DRAFTED BY:	SHEET CONTENTS:	SHEET No.
Com 3	PHILIPPINE CARABAO CENTER	PRC ID:			CONTINUATION OF THE COMPLETION		JHFR	AS SHOWN	
3	NATIONAL GENE POOL & HEADQUARTERS	PTR NO:			OF THE CONSTRUCTION		REVISION:		1 <b>/∕E-03</b> \\
an m		ISSUED ON:	ENGR. CRIS Y. GUZON	DR. ROVINA R. PIÑERA	OF INSTITUTIONAL HERD FACILITIES	DR. LIZA G. BATTAD			\(\frac{17 7}{17 }
- 1041	CLSU Cpd., Science City of Munoz, Nueva Ecija	ISSUED AT:	HEAD, LIVESTOCK ENGINEERING SECTION, PHILIPPINE CARABAO CENTER	CENTER DIRECTOR, PHILIPPINE CARABAO CENTER - CSU	AT PCC-CSU (COMMUNAL PEN 4 & 5) PIAT, CAGAYAN	EXECUTIVE DIRECTOR, PHILIPPINE CARABAO CENTER			1 1

